

MATERIAL TRANSFER SITE
SCALE: 1" = 20'


TRAVERSE POINT TABLE			
TFS #	NORTHING	EASTING	ELEVATION
1	718.793.75	1,126.881.94	514.4
2	718.315.55	1,124.881.67	514.5
3	719.029.66	1,126.322.42	545.2

STAKEOUT POINT TABLE		
POINT #	NORTHING	EASTING
1	718.826.70	1,068.134.95
2	718.802.08	1,068.775.2
3	718.266.82	1,068.838.4
4	718.200.22	1,068.858.44
5	718.100.44	1,068.875.6
6	718.133.7	1,068.806.72
7	718.650.29	1,068.528.86
8	718.634.5	1,068.27.85
9	718.605.0	1,068.333.37
10	718.50.18	1,068.56.75
11	718.553.7	1,068.548.8
12	718.458.85	1,068.572.74
13	718.41.25	1,068.554.64
14	718.310.56	1,068.505.31
15	718.318.2	1,068.403.10
16	718.242.58	1,068.818.00
17	718.21.45	1,068.863.24
18	718.250.21	1,068.133.50
19	718.214.61	1,068.168.58
20	718.205.70	1,068.172

STAKEOUT POINT TABLE		
POINT #	NORTHING	EASTING
21	718.412.82	1,068.443.80
22	718.432.28	1,068.394.44
23	718.433.64	1,068.398.40
24	718.444.53	1,068.392.1
25	718.331.1	1,068.444.58
26	718.336.6	1,068.311.6
27	718.017.86	1,068.336.31
28	718.001.60	1,068.304.1
29	718.025.60	1,068.411.6
30	718.019.80	1,068.401.31
31	718.432.80	1,068.400.24
32	718.340.8	1,068.411.43
33	718.329.42	1,068.419.04
34	718.208.41	1,068.414.05
35	718.408.44	1,068.435.56
36	718.617.6	1,068.498.11
37	718.65.34	1,068.500.80
38	718.650.36	1,068.491.03
39	718.154.23	1,068.212.20
40	718.001.82	1,068.178.35

NOTES:

- CONTRACTOR WILL REMOVE SURFACE VISIBLE RUBBLE AND DEBRIS FROM THE NO DREDGE BUFFER ZONE SURROUNDING THE PROJECT AREA.
- THE ESTIMATED MAXIMUM DREDGE VOLUME IS 14,000 CUBIC YARDS. THIS QUANTITY IS AN ESTIMATE BASED UPON THE PROPOSED ELEVATIONS AND EXISTING CONDITIONS AT THE TIME OF THE SURVEY.

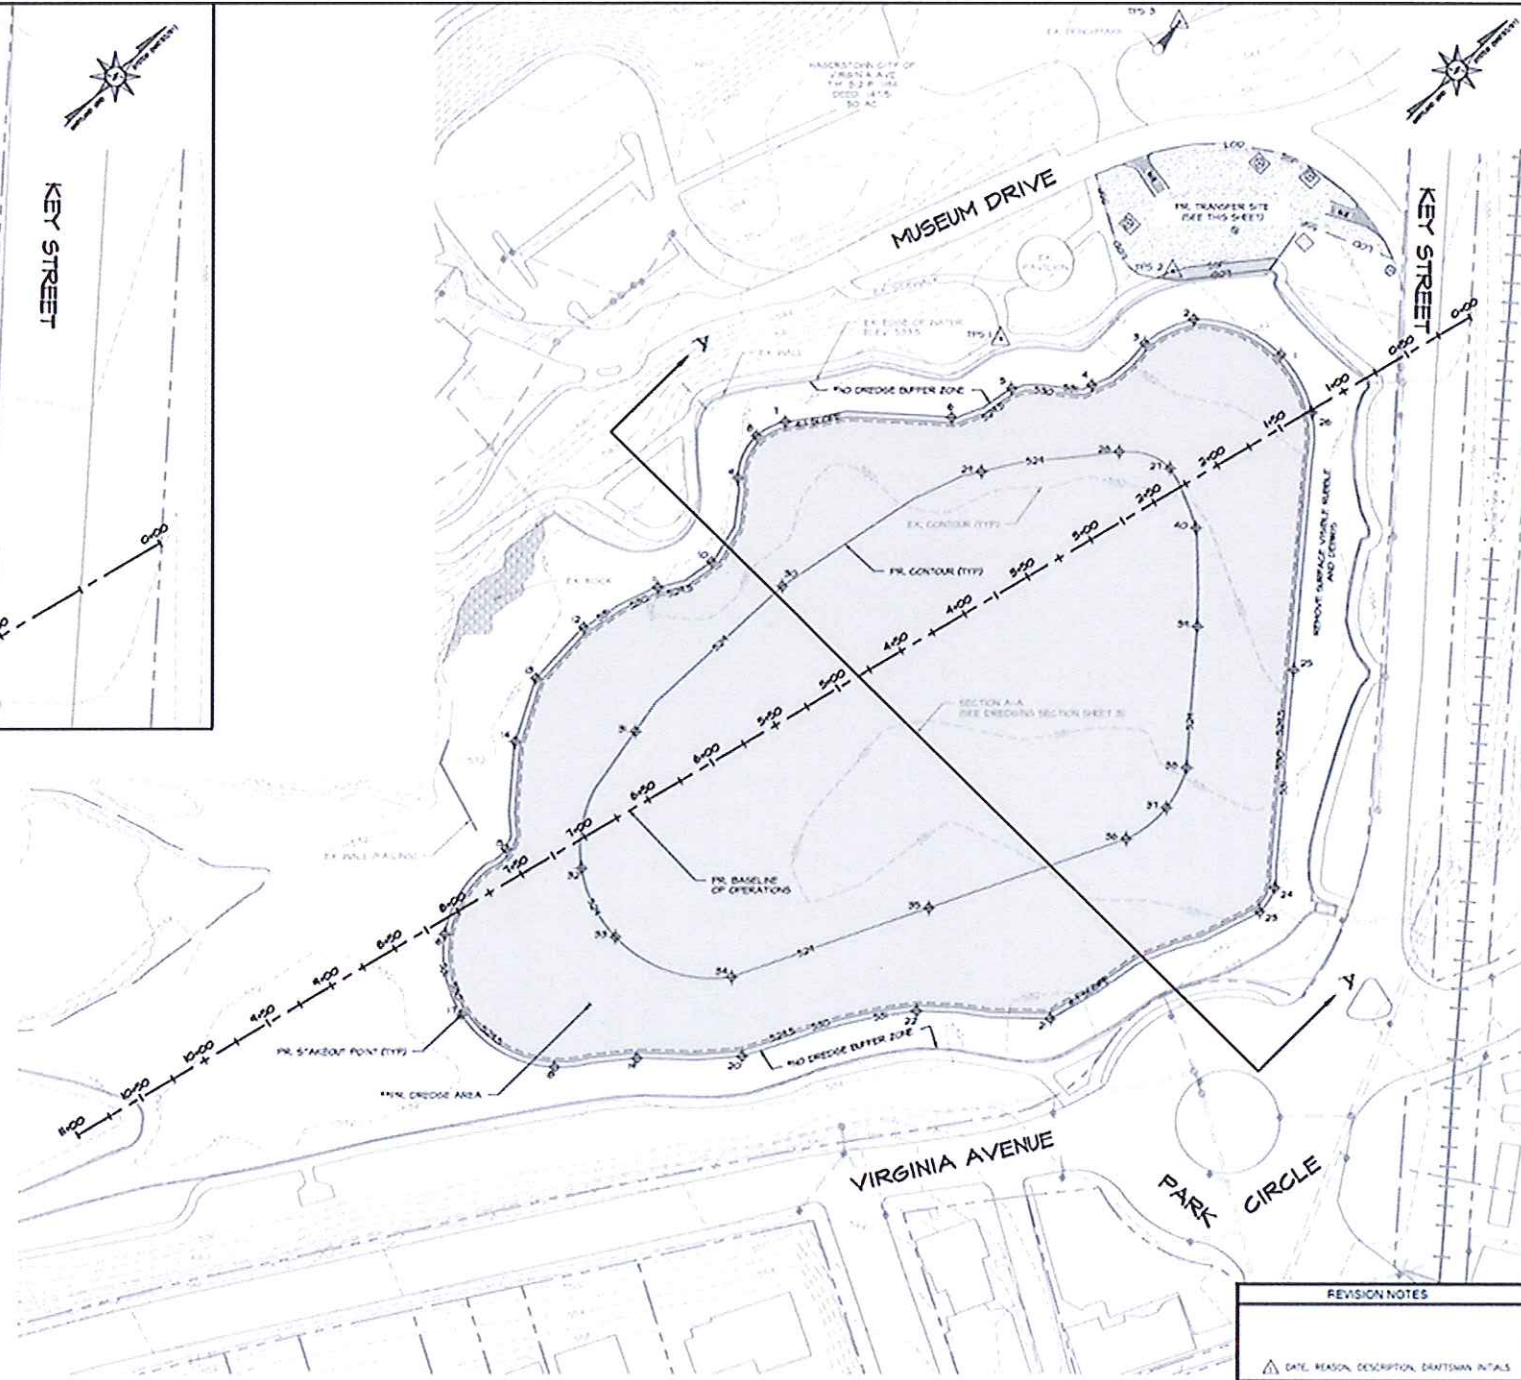

DREDGING SITE PLAN
SCALE: 1" = 50'

REVISION NOTES

DATE	REASON	DESCRIPTION	DRAWN BY	INITIALS

CITY OF HAGERSTOWN, MARYLAND
DEPARTMENT OF
PARKS AND ENGINEERING

LOCATION:
HAGERSTOWN CITY PARK

TITLE:
CITY PARK LAKE DREDGING
ULTIMATE DREDGE PLAN

SCALE: AS SHOWN

DRAWN BY	DATE
AP	8/2/16
SURVEY BY	DATE
AP/BJH/AM	1/11/16
REVISED BY	DATE
SR/SH	8/2/16

SHEET NO. 2 OF 4
80% DESIGN

COORDINATOR # _____
CHANGE ORDER # _____

Bayland
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"Integrating Engineering and Environment"

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BA5LAND JOB NO. B-23801

MDE
Maryland Department of the Environment
Water Management Administration
Dam Safety Division

Mr. P. Field
Regulatory & Compliance Engineer

Date _____

MAYOR - DAVID CRISKETS
CITY ADMINISTRATOR - VALERIE MEANS
CITY COUNCIL - KRISTIN ALESHERE
MARTIN BRUSAKER
LEWIS C. METZNER
DONALD MANSON
PENNY RICH
CITY ENGINEER - ROONEY TOSILE